1	FILE NO.	STATE PROJECT NO.	PARISH	SHEET NO.
	01/1918/2004	ME-16	CAMERON	1

# STATE OF LOUISIANA OFFICE OF COASTAL PROTECTION & RESTORATION ENGINEERING BRANCH

LA 82 FRESHWATER INTRODUCTION

ME - 16

CAMERON & VERMILLION PARISHES

AUGUST 2010



SCALE: N.T.S.



PROJECT ENGINEER

CONSULTING ENGINEER

	SHEET INDEX
SHEET NO.	DESCRIPTION
1	TITLE SHEET
2	GENERAL NOTES & LEGEND
3	SITE 1 VERMILLION-NEW COP-COP STR.
4	SITE 2 VERMILLION-STR. NO. 12
5	SITE 3 VERMILLION-STR. NO. 10
6	SITE 4 CAMERON-NEW DYSON STR.
	CITE & CAMEDON LITTLE CONSTANCE


# **RECORD DRAWING AS-BUILT**

DECEMBER 22, 2011 (CHANGES PROVIDED BY CONTRACTOR)



# TYPE OF CONSTRUCTION:

III. HEAVY CONSTRUCTION HYDROLOGIC RESTORATION

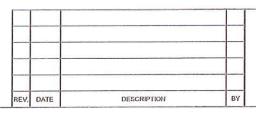







OFFICE OF COASTAL PROTECTION & RESTORATION ENGINEERING BRANCH

450 LAUREL STREET
BATON ROUGE, LOUISIANA 70801

DRAWN BY: R.C.M.

DESIGNED BY: T.G.B.

LA 82 FRESHWATER INTRODUCTION	TITLE SHEET	
STATE PROJECT NUMBER: ME-16		
FEDERAL PROJECT NUMBER: ME-16	DATE: AUGUST 2010	
APPROVED BY:	SHEET 1 OF 7	

ENGINEER MANAGER

STATE OF LOUISIANA

INSET MAP


ENGINEER SUPERVISOR

### GENERAL NOTES:

- CONSTRUCTION CLASSIFICATION IS CLASS III HEAVY CONSTRUCTION - HYDROLOGIC RESTORATION.
- CONTRACTOR IS RESPONSIBLE FOR CONSTRUCTION SAFETY.
- CONTRACTOR HAS PERSONALLY INSPECTED AND IS FAMILIAR WITH THE PROJECT SITE, AND SHALL PROVIDE ALL LABOR, MATERIALS, TOOLS, APPLIANCES AND FACILITIES AS REQUIRED TO PERFORM, IN A WORKMANLIKE MANNER, ALL WORK AND SERVICES FOR THE CONSTRUCTION AND COMPLETION OF THE PROJECT, ALL IN STRICT ACCORDANCE WITH THE CONTRACT DOCUMENTS.
- ALL BID QUANTITIES WHERE ESTIMATED BY THE ENGINEER. THE CONTRACTOR WILL BE PAID BASED UPON ACTUAL QUANTITIES AS VERIFIED BY THE OWNER AND ENGINEER AT THE UNIT PRICES AS SHOWN ON THE EXECUTED BID FORM.
- WORK SHALL BE PERFORMED IN ACCORDANCE WITH THE PLANS, SPECIFICATIONS, AND THE LOUISIANA STANDARD SPECIFICATIONS FOR ROADS AND BRIDGES, 2006 EDITION.
- CONTRACTOR SHALL BE FAMILIAR AND REMAIN IN COMPLIANCE WITH ALL FEDERAL, STATE, AND LOCAL LAWS, ORDINANCES, AND REGULATIONS WHICH MAY AFFECT ALL EMPLOYEES AND EXECUTION OF THE WORK.
- THE WORK SHALL BE CONDUCTED USING SUFFICIENT LABOR, MATERIALS, AND EQUIPMENT AND NECESSARY APPURTENANCES TO ENSURE COMPLETION OF THE PROJECT WITHIN THE CONTRACT TIME.
- REFER TO GENERAL PROVISIONS GP-8 FOR REQUIRED WORK PLAN AND GP-9 FOR PROGRESS SCHEDULE.
- THE CONTRACT DOCUMENTS ARE COMPLEMENTARY; WHAT IS CALLED FOR BY ONE IS AS BINDING AS IF CALLED FOR BY ALL. CLARIFICATIONS AND INTERPRETATIONS OR NOTIFICATIONS OF MINOR VARIATIONS AND DEVIATIONS OF THE CONTRACT DOCUMENTS WILL BE ISSUED BY ENGINEER AS PROVIDED IN THESE SPECIFICATIONS. ANY LABOR, DOCUMENTATION, SERVICES, MATERIALS, OR EQUIPMENT THAT MAY REASONABLY BE INFERRED FROM THE CONTRACT DOCUMENTS OR FROM PREVAILING CUSTOM OR TRADE USAGE AS BEING REQUIRED TO PRODUCE THE INTENDED RESULT WILL BE PROVIDED AT NO ADDITIONAL COST TO THE OWNER.
- 10. REFER TO GENERAL PROVISIONS GP-16 FOR AUTHORITY OF ENGINEER.


- 11. THE CONTRACTOR IS RESPONSIBLE FOR CONSTRUCTION STAKING AND LAYOUT.
- 12. THE CONTRACTOR SHALL PROVIDE ALL REQUIRED SANITARY FACILITIES REQUIRED FOR ALL EMPLOYEES AND SUB CONTRACTORS FOR THE ENTIRE DURATION OF THE WORK.
- 13. CONTRACTOR SHALL BE RESPONSIBLE FOR ALL CLEARING AND GRUBBING, STRIPPING, AND ALL DEMOLITION AND OR REMOVAL OF STRUCTURES AND OBSTRUCTIONS AS REQUIRED, IF ANY, AND OR AS SHOWN ON THE DRAWINGS TO ENSURE PROPER CONSTRUCTION OF THE DESIGN INTENT AND PROPER DISPOSAL OF ALL REMOVED MATERIALS.
- 14. ITEMS TO BE CLEARED, REMOVED, DEMOLISHED, ETC., THAT CHANGE THE SCOPE OF THE WORK AS INTENDED HEREIN OR DIFFER SIGNIFICANTLY FROM THOSE ITEMS INDICATED WITHIN THESE DRAWINGS SHALL BE REVIEWED AND DISCUSSED WITH THE PROJECT ENGINEER PRIOR TO ACTION OR NO ADDITIONAL PAY WILL BE CONSIDERED.
- 15. CONTRACTOR SHALL PROTECT FROM DAMAGE ALL PROPERTY AND FACILITIES NOT REQUIRING WORK. ANY DAMAGE TO NON WORK PROPERTIES AND OR FACILITIES DUE TO THE CONTRACTORS OPERATIONS WILL BE REPAIRED BY THE CONTRACTOR AT THE CONTRACTORS COST. THE ENGINEER WILL APPROVE ALL REPAIR WORK.
- CONTRACTOR SHALL REPAIR ALL AREAS DISTURBED DUE TO CONSTRUCTION INCLUDING DRESS GRADING IN PREPARATION OF FINAL AND PERMANENT EROSION CONTROL, CONTRACTOR SHALL WATER EROSION CONTROL UNTIL CONSTRUCTION AREAS HAVE ACHIEVED 80% COVERAGE. TEMPORARY EROSION CONTROL FACILITIES SHALL NOT BE REMOVED UNTIL APPROVED BY THE ENGINEER.
- TOPOGRAPHICAL INFORMATION IS PROVIDED FOR THE CONTRACTORS USE. THE CONTRACTOR SHALL VERIFY ALL EXISTING CONDITIONS PRIOR TO CONSTRUCTION. A SUBSURFACE INVESTIGATION WAS NOT PERFORMED NOR WAS ONE REQUESTED. THE CONTRACTOR SHALL PROVIDE HIS OWN SUB SURFACE INVESTIGATION IF SO NEEDED BUT SHALL HAVE PLAN FOR SUCH APPROVED BY THE ENGINEER.

FILE NO.	STATE PROJECT NO.	PARISH	SHEET NO.
01/1918/2004	ME-16	CAMERON	1

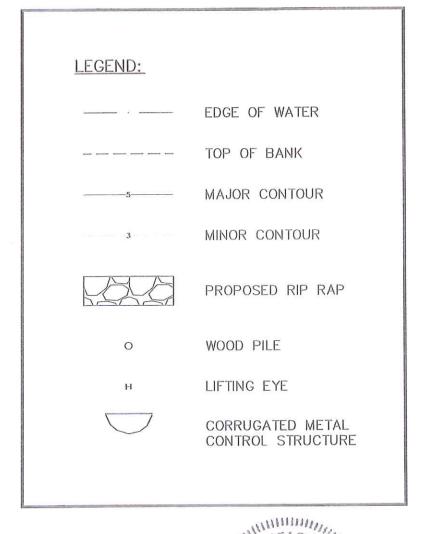

**AS-BUILT** 

DECEMBER 22, 2011 (NO CHANGE)

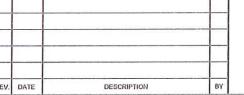







OFFICE OF COASTAL PROTECTION & RESTORATION ENGINEERING BRANCH

450 LAUREL STREET BATON ROUGE, LOUISIANA 70801

DRAWN BY: R.C.M.

LA 82 FRESHWATER INTRODUCTION GENERAL NOTES AND LEGEND STATE PROJECT NUMBER: ME-16 DATE: AUGUST 2010 FEDERAL PROJECT NUMBER ME-16

E TANTA GILBERT-BAKER


License No. 29350


PROFESSIONAL ENGINEER

上面い


ENGINEER! THE ENGINEE STREET

SHEET 2 OF 7 APPROVED BY: DESIGNED BY: T.G.B.

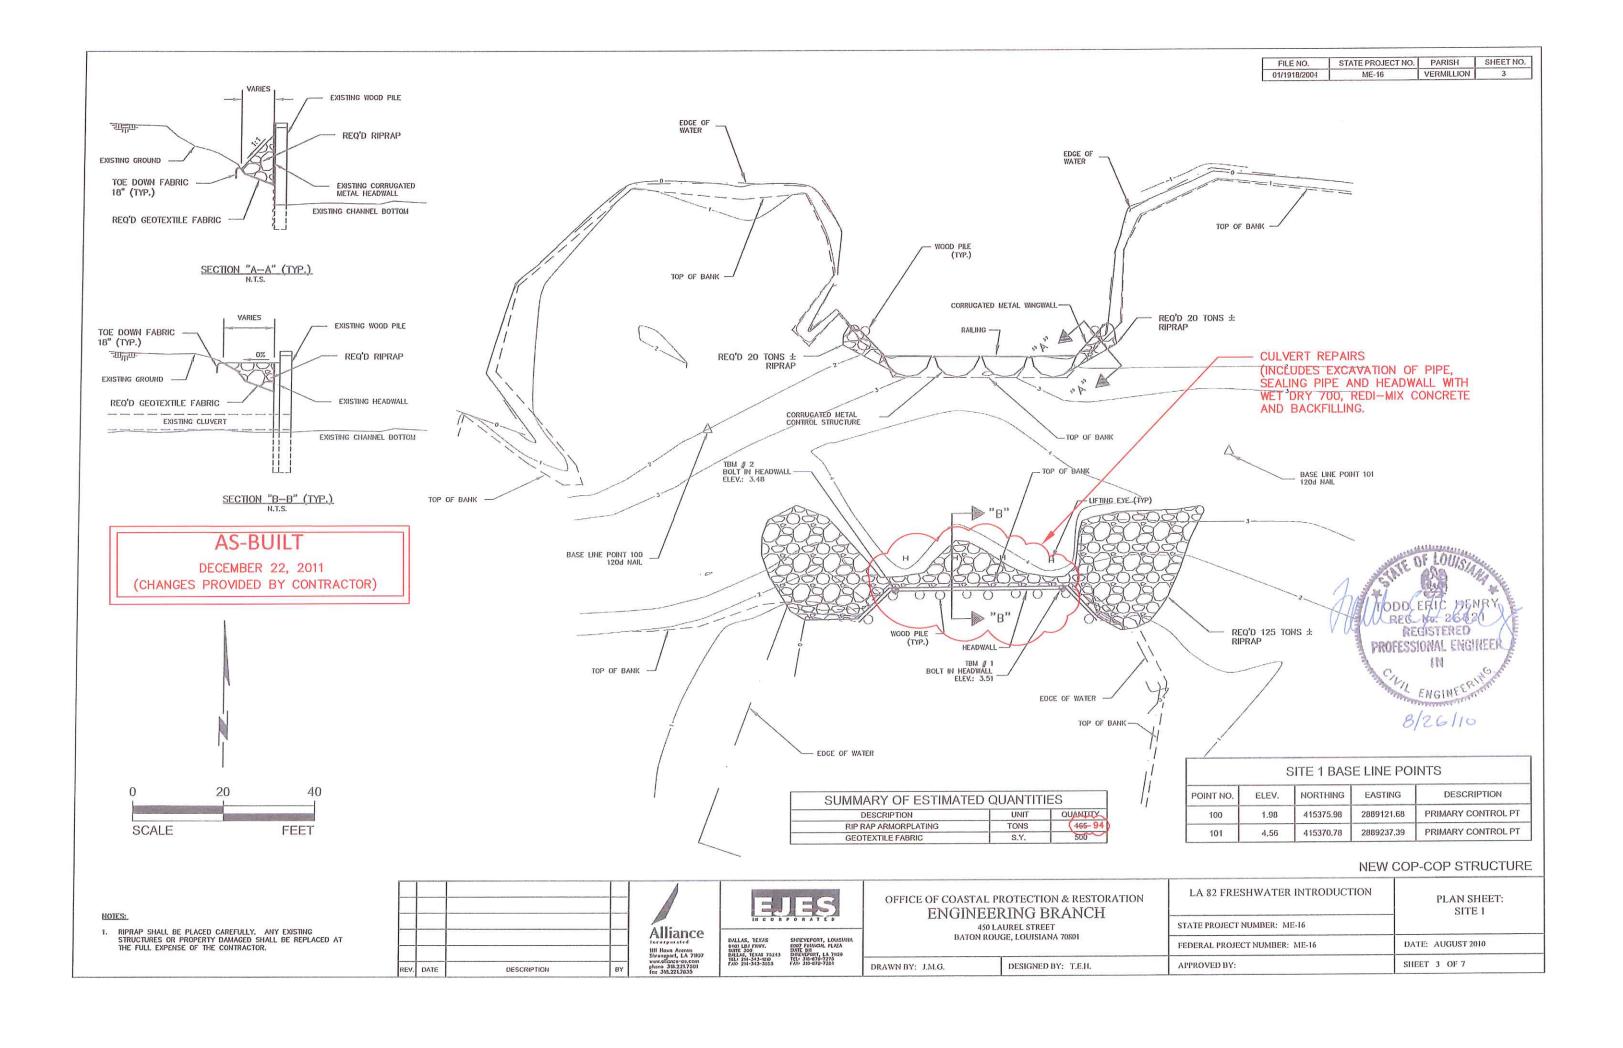

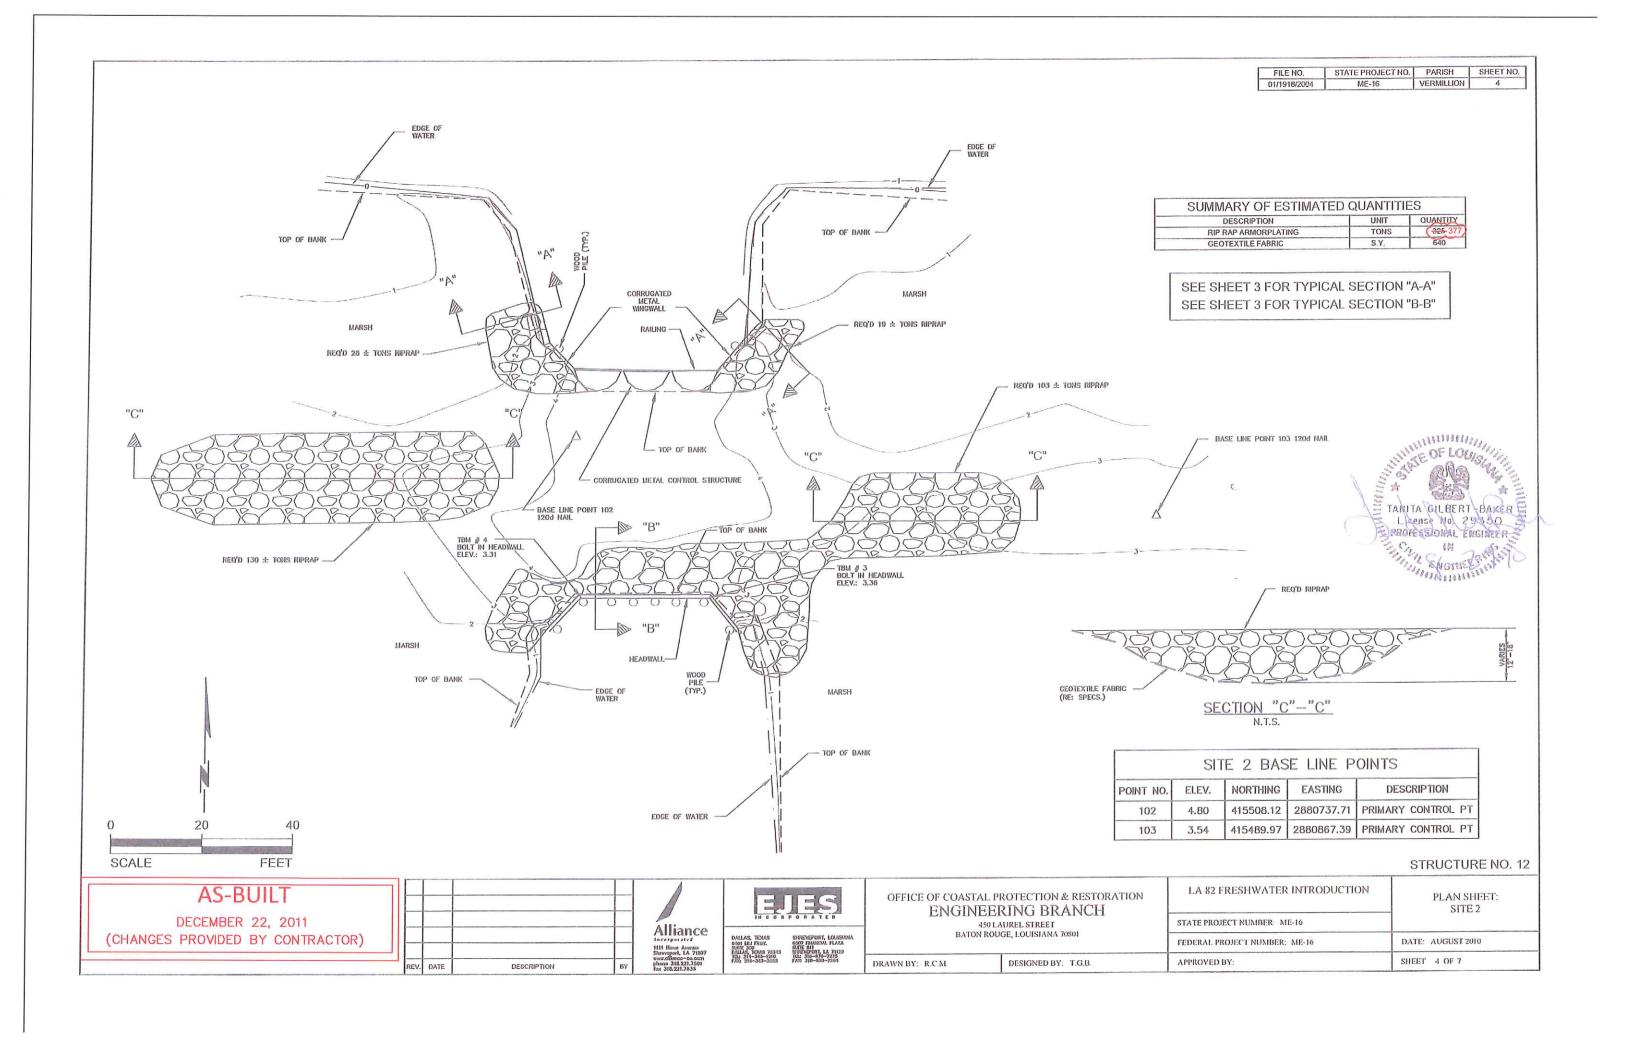

FILE NO.	STATE PROJECT NO.	PARISH	SHEET NO
01/1918/2004	ME-16	VERMILLION	5

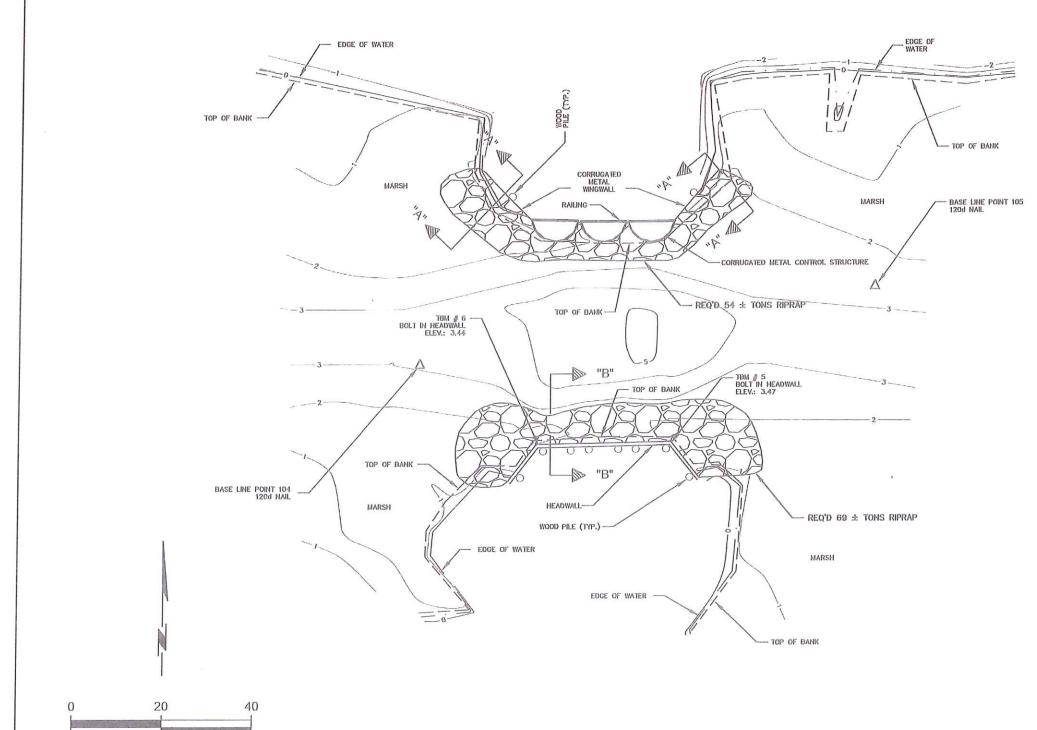



SUMMARY OF ESTIMATE	ED QUANTIT	IES
DESCRIPTION	UNIT	QUANTITY
RIP RAP ARMORPLATING	TONS	(125-159)
GEOTEXTILE FABRIC	S.Y.	300

SEE SHEET 3 FOR TYPICAL SECTION "A-A" SEE SHEET 3 FOR TYPICAL SECTION "B-B"

SITE 3 BASE LINE POINTS					
POINT NO.	ELEV.	NORTHING	EASTING	DESCRIPTION	
104	3.09	416885.90	2875811.07	PRIMARY CONTROL PT	
105	2.51	416903.49	2875912.40	PRIMARY CONTROL PT	

### STRUCTURE NO. 10

# **AS-BUILT**

FEET

SCALE

DECEMBER 22, 2011 (CHANGES PROVIDED BY CONTRACTOR)

_			11
DATE	DESCRIPTION	ВҮ	fi Si w pl

Alliance Incorputated Shrewsport, LA 71107 www.offenes-ex.com phone 318.221.7501 fex 318.221.7635



OFFICE OF COASTAL PROTECTION & RESTORATION ENGINEERING BRANCH
450 LAUREL STREET
BATON ROUGE, LOUISIANA 70801

DESIGNED BY: T.G.B.

	CALLERY DESCRIPTION SHOWS THE PROPERTY OF THE PARTY OF TH
LA 82 FRESHWATER INTRODUCTION	PLAN SHEET: SITE 3
STATE PROJECT NUMBER: ME-16	
FEDERAL PROJECT NUMBER: ME-16	DATE: AUGUST 2010
APPROVED BY:	SHEET 5 OF 7

